




Willamette Valley Homes

AND ROOF PI

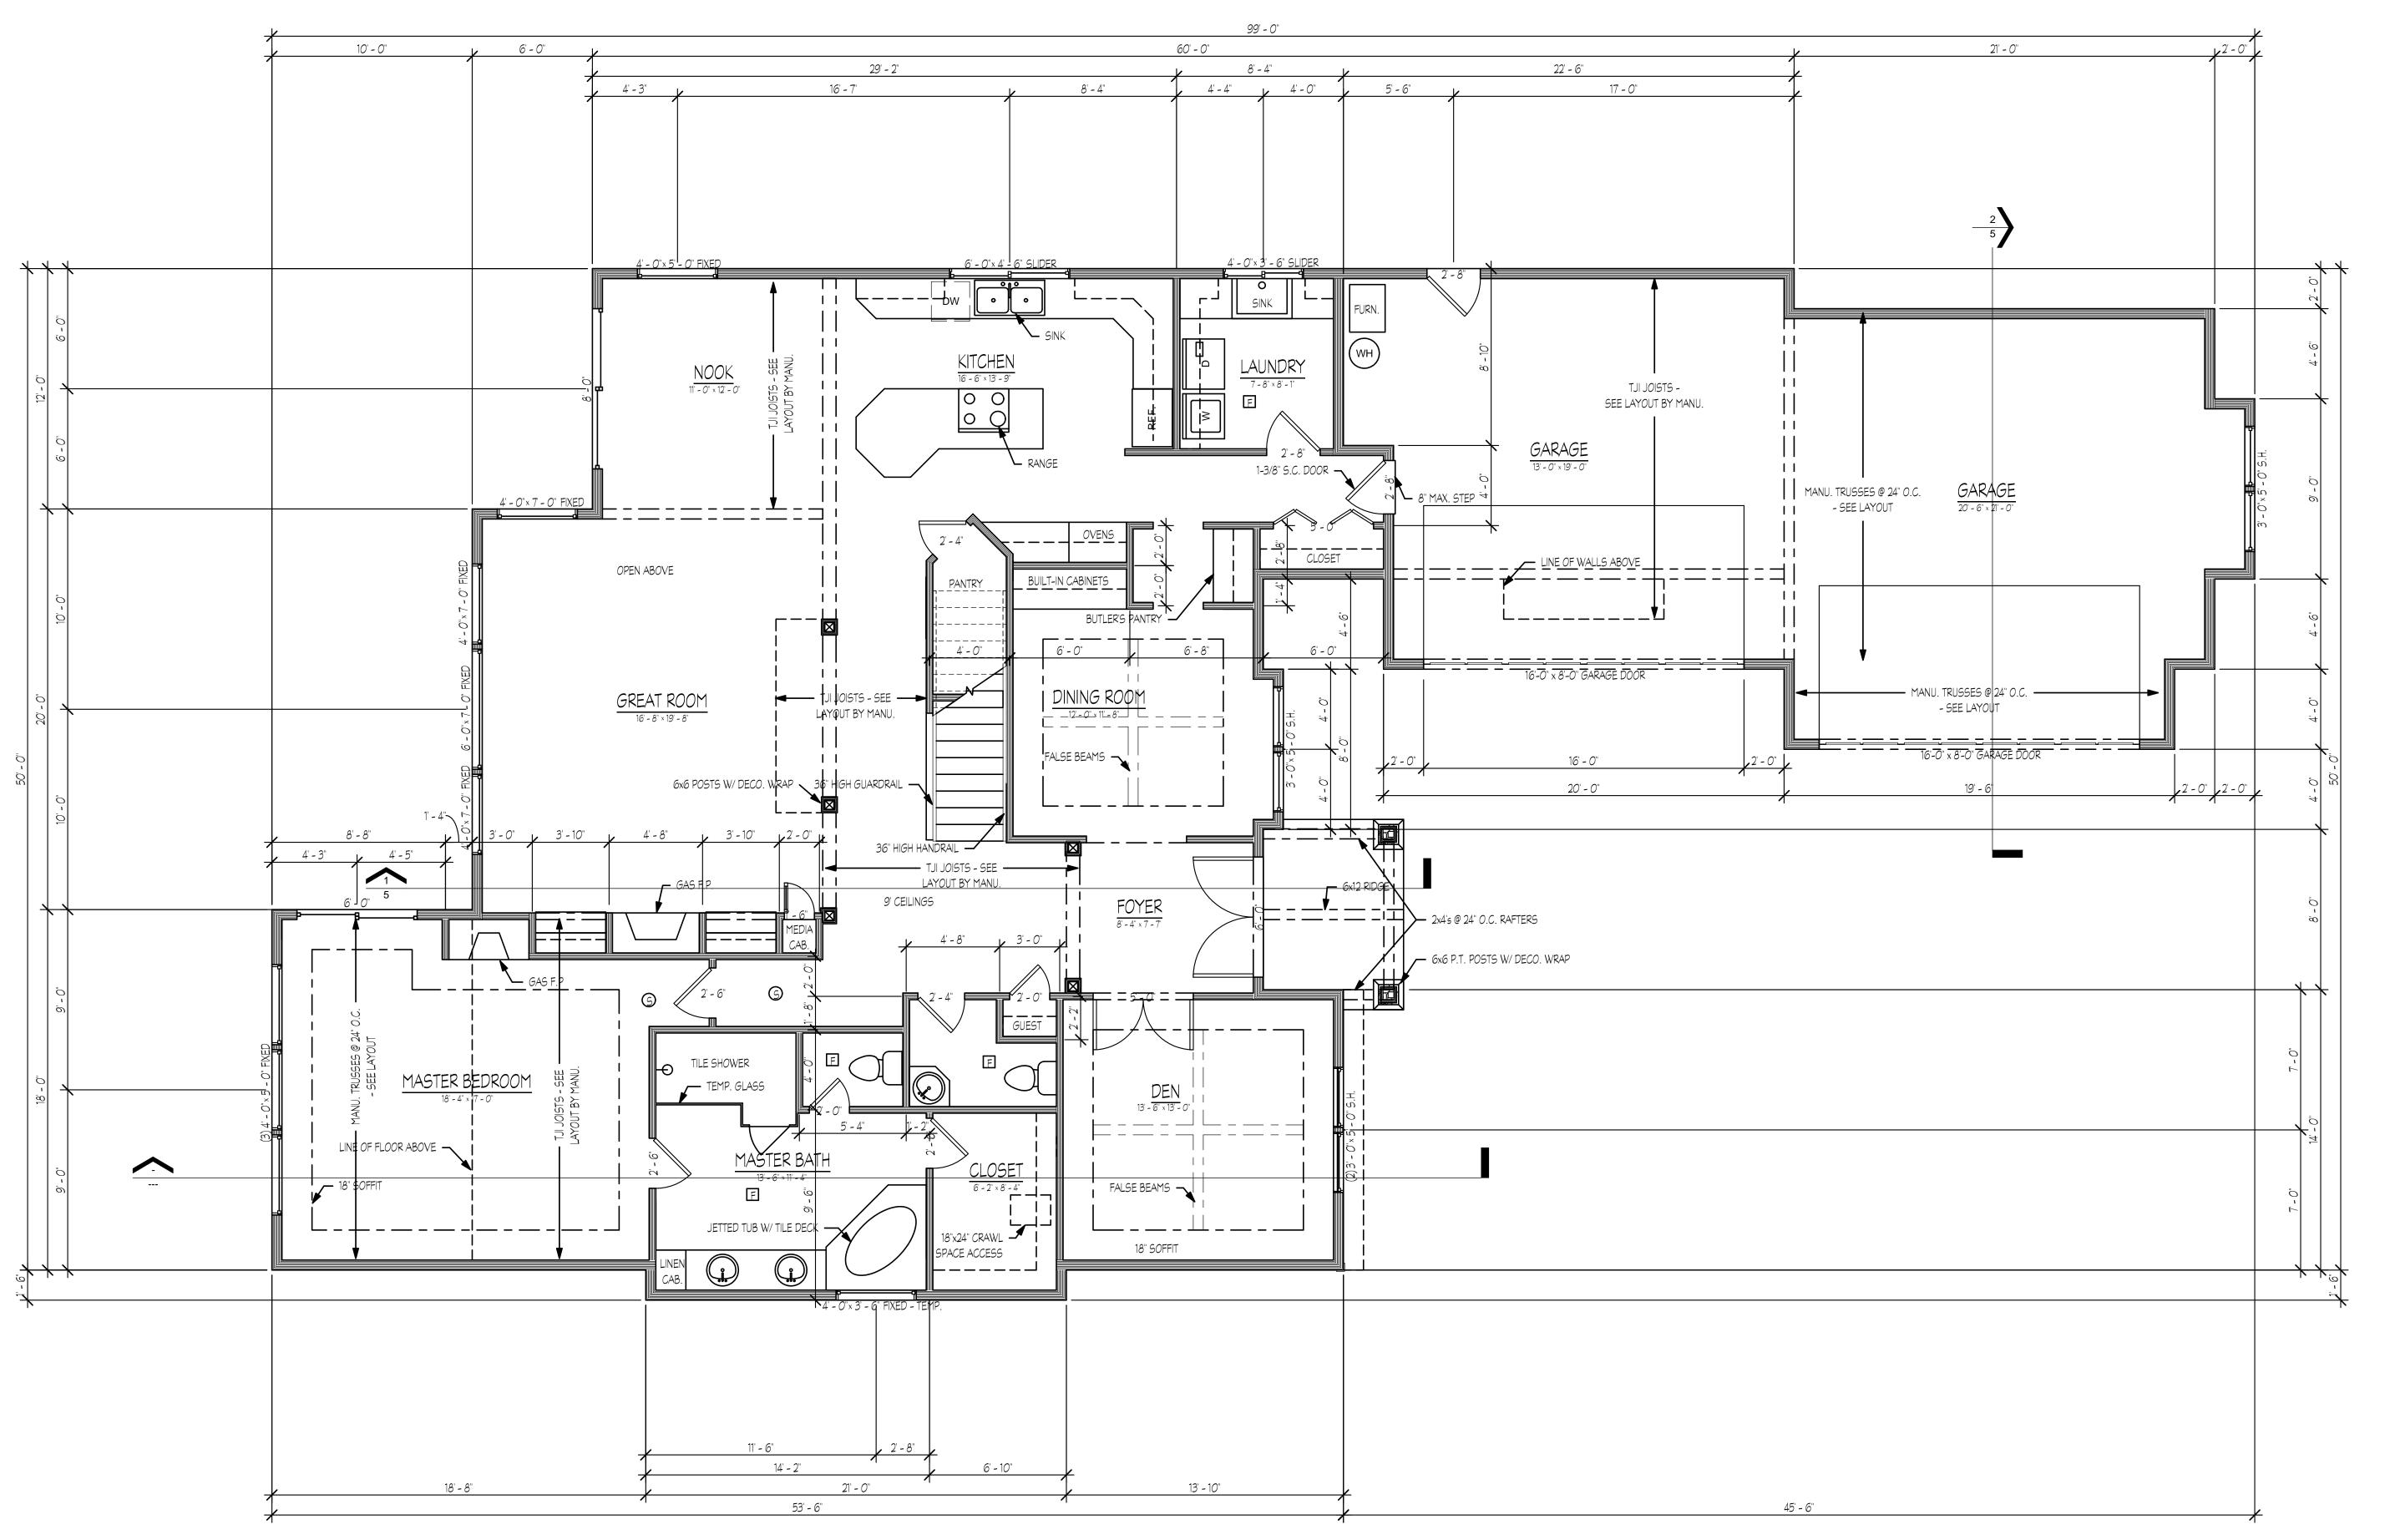


FIRST FLOOR PLAN

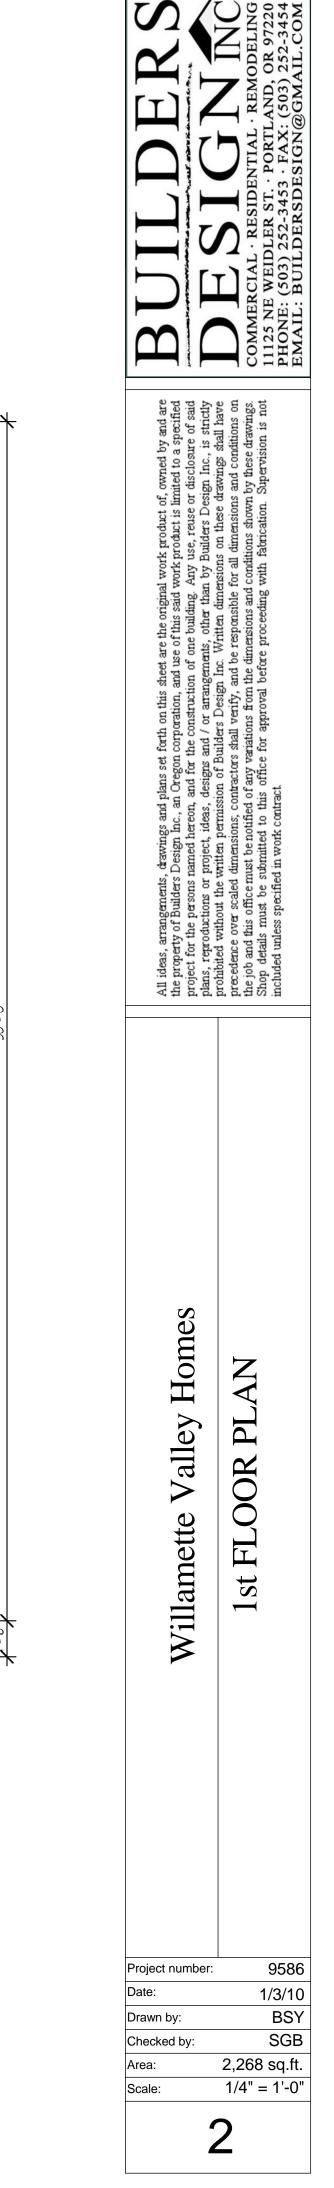

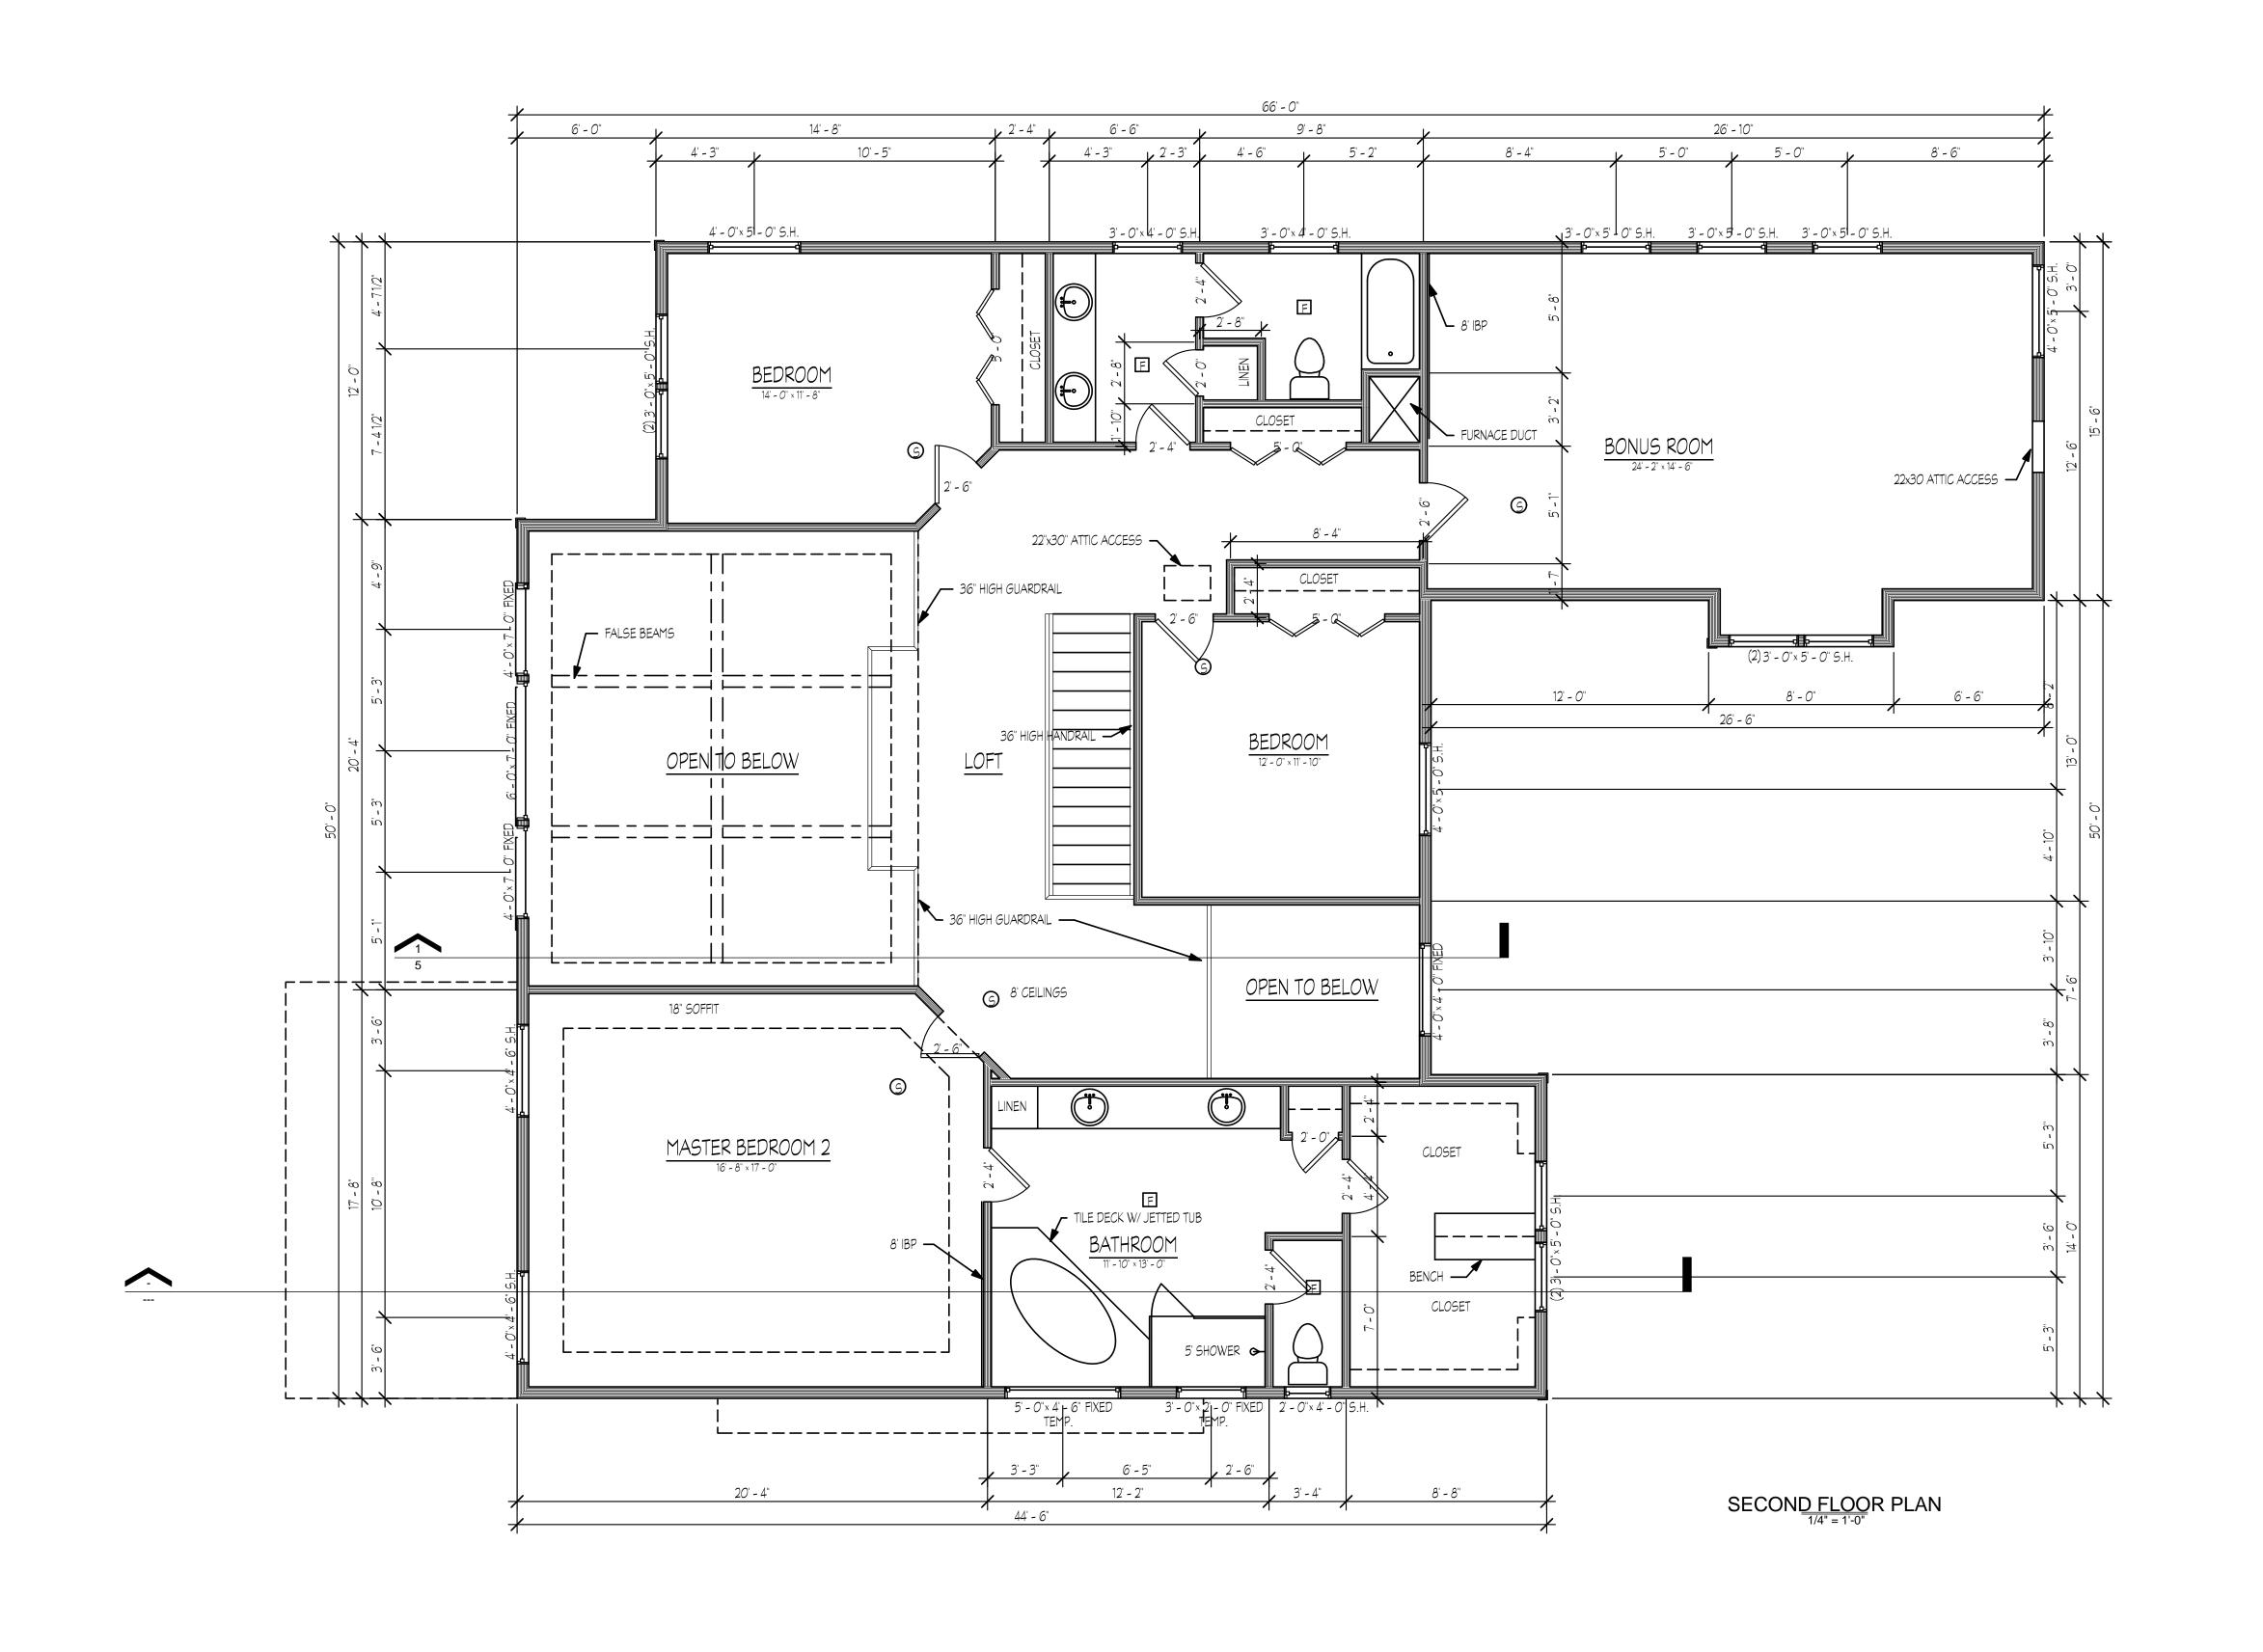

BUILDERS	COMMERCIAL · RESIDENTIAL · REMODELING 11125 NE WEIDLER ST. · PORTLAND, OR 97220 PHONE: (503) 252-3453 · FAX: (503) 252-3454 EMAIL: BUILDERSDESIGN@GMAIL.COM
All ideas, arrangements, drawings and plans set forth on this sheet are the original work product of, owned by and are the property of Builders Design Inc., an Oregon corporation, and use of this said work product is limited to a specified project for the persons named hereon, and for the construction of one building. Any use, reuse or disclosure of said plans, reproductions or project, ideas, designs and / or arrangements, other than by Builders Design Inc., is strictly	promoted without the written permission of builders Design inc. Written dimensions on these drawings shall have precedence over scaled dimensions, contractors shall verify, and be responsible for all dimensions and conditions on the job and this office must be notified of any variations from the dimensions and conditions shown by these drawings. Shop details must be submitted to this office for approval before proceeding with fabrication. Supervision is not included unless specified in work contract.
Willamette Valley Homes	SECOND FLOOR PLAN
Project number: Date: Drawn by: Checked by: Area: Scale:	9586 1/3/10 BSY SGB 1,935 sq.ft. 1/4" = 1'-0"

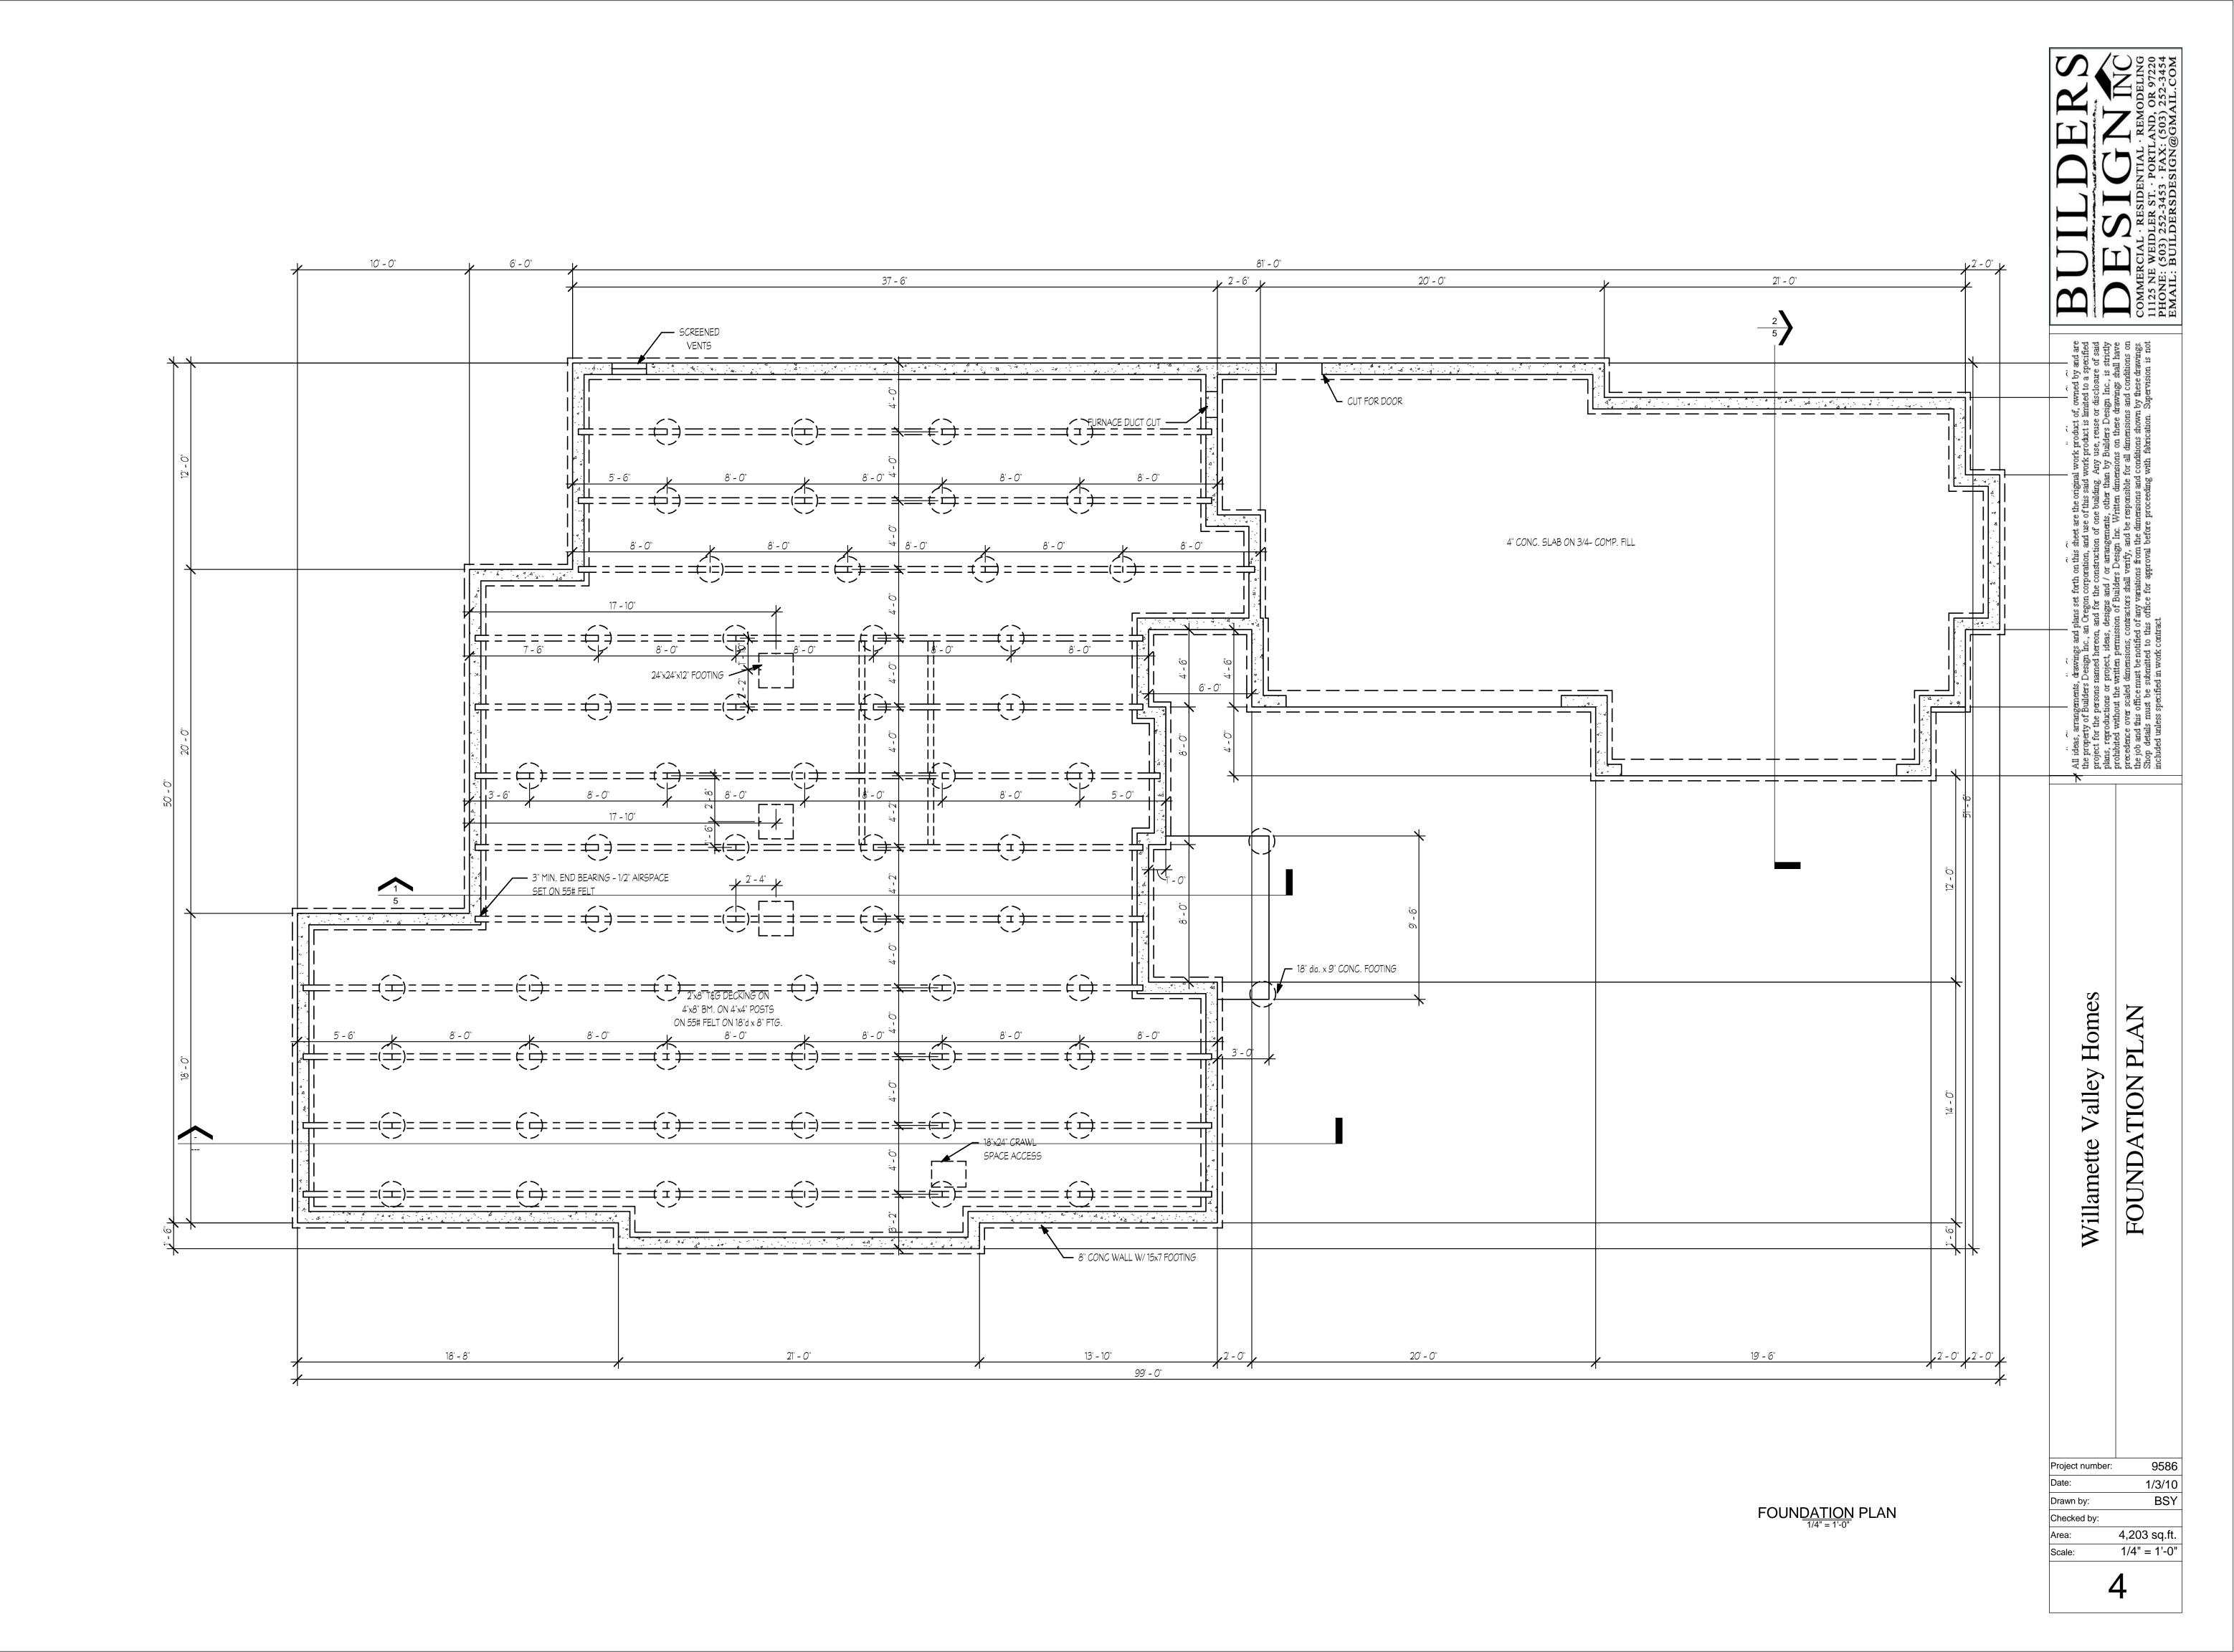

GENERAL CONDITIONS

1. ALL WORK SHALL CONFORM WITH THE LATEST ADOPTED ISSUE OF THE OREGON 2008 RESIDENTIAL SPECIALTY CODE AND ANY APPLICABLE STATE, COUNTY, OR LOCAL REGULATIONS.

2. THE CONTRACTOR IS RESPONSIBLE FOR CHECKING THE PLANS AND SITE CONDITIONS AND TO NOTIFY THE ARCHITECT OF ANY ERRORS OR OMISSIONS PRIOR TO THE START OF CONSTRUCTION.

3. WRITTEN DIMENSIONS HAVE PRECEDENCE OVER SCALED DIMENSIONS SITE WORK

1. REMOVE TOP SOIL AND ORGANIC MATERIAL FROM THE BUILDING SITE, STOCKPILING ON SITE FOR FINAL GRADING IF POSSIBLE.

2. FOOTINGS ARE TO BEAR ON UNDISTURBED LEVEL SOIL, STEPPED AS REQUIRED TO MAINTAIN THE REQUIRED DEPTH BELOW FINISH GRADE.

3. ANY FILL UNDER GRADE SUPPORTED CONCRETE SLABS TO BE 4" THICK (MIN.) SAND

COMPACTED TO 95%.
4. CONCRETE SLABS TO BE 4" THICK, 3000 P.S.I AT 28 DAYS WITH CONTROL JOINTS AT 25' O/C (MAX.) EACH WAY

5. FINISH GRADES ARE TO REMAIN AT LEAST 6" BELOW FINISH SIDING.

FOUNDATIONS

1 CONCRETE - MIX AND 28 DAY STRENGTH OF CONCRE

CONCRETE - MIX AND 28 DAY STRENGTH OF CONCRETE
 BASEMENT WALLS & FOUNDATION
 NOT EXPOSED TO WEATHER
 2500 PSI

- BASEMENT & INTERIOR

SLABS ON GRADE: 2500 PSI
- BASEMENT WALLS & FOUNDATIONS

EXPOSED TO WEATHER

AND GARAGE SLABS: 3000 PSI
-PORCHES, STEPS & CARPORT
SLABS EXPOSED TO WEATHER: 3000 PSI

3. LAP ALL CONTINUOUS BARS 30 x DIA. (MIN.) PLACE ALL REINFORCING AS PER A.C.I. CODES & STANDARDS.

2. ALL REINFORCING STEEL TO BE A-615 GRADE 60. WELDED WIRE MESH TO BE A-

4. PROVIDE A MINIMUM CLEARANCE OF 18" UNDER GIRDERS, BEAMS, OR JOISTS.

5. COVER ENTIRE CRAWL SPACE WITH 6 MIL. BLACK "VISQUEEN" AND EXTEND UP

FOUNDATION WALLS AND FASTEN TO MUD SILL
6. PROVIDE A MINIMUM OF 1 S.F. OF NET VENTILATION AREA FOR EACH 1500 S.F. OF
CRAWL SPACE AREA. VENTS ARE TO BE CLOSABLE AND HAVE 1/4" OPENINGS IN
CORROSIVE RESISTANT SCREEN. POST NOTICE ABOUT OPENING VENTS NEAR

ELECTRICAL PANEL.

7. ALL WOOD IN CONTACT WITH CONCRETE TO BE PRESSURE TREATED.

8. BEAM POCKETS IN CONCRETE WALLS TO HAVE 1/2" AIR SPACE AT SIDES AND ENDS AND 3" OF BEARING (MIN.)

9. MUD SILLS TO BE 2x6 PRESSURE TREATED WOOD WITH 1/2" DIA. x 10" ANCHOR BOLTS SPACED 6'-O" O/C, OR PER SHEAR WALL SCHEDULE AND WITHIN 12" OF CORNERS. LAYOUT FOR 14' LONG 2x6 P.T. SILL PLATE, PROVIDE AB. EACH SIDE OF SILL SPLICES.

10. PROVIDE 4" DIA. PERFORATED DRAIN TILE BELOW THE TOP OF FOOTINGS.

FLASHING & MOISTURE PROTECTION

1. CONTRACTOR TO PROVIDE A "WATER TIGHT ENCLOSURE" FOR THE VALLEY

THE WASHINGTON AS THE MICHAEL SHADOW AND THE WASHINGTON AND THE WA

ENVIRONMENT, EMPLOYING THE HIGHEST QUALITY MATERIALS, CRAFTSMAN AND CONSTRUCTION METHODOLOGY, BOTH GENERAL AND SPECIFIC TO THE VALLEY

2. ALL EXTERIOR FLASHING ARE TO BE CONSTRUCTED WITH MIN. GAGE 28 EXPOSED \$

30 GAGE CONCEALED, BAKED ENAMEL

3. FLASHING SHALL BE INSTALLED AT JUNCTIONS OF CHIMNEYS AND ROOFS, IN ROOF VALLEYS AND AROUND ALL ROOF OPENINGS, INCLUDING SKYLIGHTS, ROOF VENTS,

ROOF EDGES BOTH RAKE AND EAVE.

4. FLASHING SHALL BE INSTALLED AROUND ALL EXTERIOR DOORS AND WINDOWS,

TRANSITIONS BETWEEN CIDING AND POOF

TRANSITIONS BETWEEN SIDING AND ROOF.

5. ALL FLASHING TO BE INSTALLED PER "SMACNA" LATEST EDITION OF THE "ARCHITECTURAL CLIEFT METAL MANUAL".

"ARCHITECTURAL SHEET METAL MANUAL".

6. BUILDING WRAP OF "TYVEK" OR SAME TO BE INSTALLED PER MANUFACTURERS INSTRUCTIONS, INCLUDING WRAPPING WINDOW AND DOOR OPENINGS AND TAPING

JOINTS.
7. FLASHING FOR WINDOWS: INSTALL ADHESIVE FLASHING THE WIDTH OF SILL AND UP 12" EACH JAMB, AND LAP ENTIRE LENGTH OF JAMB, AND LAP ADHESIVE FLASHING THE WIDTH OF HEAD AND LAP 12" DOWN EACH JAMB. (DETAIL)

NAILING SCHEDULE:

JOIST TO SILL OF GIRDER: (3) 8d TOE NAIL (2) 8d TOE NAIL BRIDGE TO JOIST 16d@16" O.C. BOTTOM PLATE TO JOIST FACE NAIL PLYWOOD SUBFLOOR 8d@66" EDGE NAIL INTERIOR 8d @ 12" TOP PLATE TO JOIST (2)16d END NAIL STUD TO BOTTOM PLATE (4)8dTOE OR END NAIL 16d@ 16" O.C. DOUBLE STUDS FACE NAIL DOUBLE TOP PLATE 16d@ 16" O.C. FACE NAIL 16d@ 16" O.C. EDGE NAIL CONTINUOUS HEADER (2 PC) CEILING JOIST TO PLATE (3) 8d FACE NAIL CEILING JOIST LAP OVER PLATE (3) 16d FACE NAIL (3) 16d CEILING JOIST TO RAFTER FACE NAIL RAFTER TO TOP PLATE (3) 8d TOE NAIL COLLAR TIES (EACH END) (6) 10d (U.N.O.) FACE NAIL 16d @ 24" O.C. BUILD UP CORNER STUDS FACE NAIL TOP PLATE AT INTERSECTIONS (2) 16d FACE NAIL MULTIPLE LVL'S (2 PLIES) 2 ROWS - 16d @ 12" O.C. STAGGERED MULTIPLE LVL'S (3 PLIES) 2 ROWS - 16d @ 12" O.C. STAGGERED 2 ROWS - 16d @ 12" O.C. STAGGERED MULTIPLE JOISTS (UP TO 3) 1x6 SPACED SHEATHING (2) 8d FACE NAIL (4) 16d RAFTERS TO HIPS, VALLEY OR RIDGE

SPECIAL NOTE:

1. THE CONTRACTOR IS RESPONSIBLE TO CHECK THE PLANS AND IS TO NOTIFY THE DESIGNER OF ANY ERRORS OR OMISSIONS PRIOR TO THE START OF CONSTRUCTION.IT IS THE BUILDER AND SUB-CONTRACTORS RESPONSIBILITY TO READ THESE PLANS AND TO NOTIFY THE DESIGNER OF ANY MATERIAL DISCREPANCIES PRIOR TO ANY ON-SITE FABRICATION OR CONSTRUCTION.FIELD VERIFY ALL EXISTING SUBSTRATES AND INSTALL INFILLS AS REQUIRED BY CODE AND/OR EXISTING CONDITIONS.

2. ALL WORK IS TO COMPLY WITH THE LATEST ADOPTED VERSION OF THE OREGON RESIDENTIAL SPECIALTY CODE AND ANY APPLICABLE STATE, COUNTY, OR LOCAL REGULATIONS.

FOUNDATIONS

1. WOOD FRAMING MEMBER GRADES ARE AS FOLLOWS UNLESS, OTHERWISE NOTED ON THE DRAWINGS:

A. POSTS, BEAMS, HEADERS, JOISTS AND RAFTERS - NO. 1 HEM FIR OR LVL'S - 2650 FB & 1.8E

B. PLATES, BLOCKING AND BRIDGING - NO. 3 HEM FIR

C. STUDS - STUD GRADE HEM FIR

C. STUDS - STUD GRADE HEM FIR

D. T&G DECKING - STUD & BETTER GRADE HEM FIR

E. PLY. SHEATHING - CD HEM FIR PLY. (32/16)

F. GLU-LAM - 24-F V-4

2. UNLESS OTHERWISE NOTED ON DRAWINGS, ALL EXTERIOR WINDOW AND DOOR HEADERS ARE TO BE 4x12 HEM FIR No. 1

3. PROVIDE DOUBLE JOISTS UNDER ALL BEARING PARTITIONS.
4. DESIGN LOADS: ROOF - 25 P.S.F. (LL)

- 25 P.S.F. (LL) FLOOR - 40 P.S.F. (LL) STAIRS - 100 P.S.F. (LL) GARAGE FLOOR - 50 P.S.F. (LL) DECKS - 40 P.S.F. (LL)

5. SOIL BEARING PRESSURE IS ASSUMED TO BE 1500 P.S.F.
6. NAILING SCHEDULE AS PER TABLE 25-Q, U.B.C., TYPICAL PLYWOOD NAILING WITH 8d NAILS @ 6" O/C AT EDGES AND 12" O.C. FIELD.

7. DECK AND BALCONY GUARDRAILS TO BE 36" HIGH WITH MAXIMUM OPENING SPACES SO THAT A 4" SPHERE CAN NOT PASS THROUGH.

8. PROVIDE METAL TRUSS AND RAFTER TIE DOWNS SUCH AS A, "SIMPSON" H2.5 TO EACH RAFTER AT TOP PLATE.


9. ALL EXTERIOR FASTENERS, EXPOSED TO THE ELEMENTS TO BE STAINLESS STEEL OR GALVANIZED. INCLUDING

36" HIGH HANDRAIL

NAIL, STAPLES, CLIPS, ETC. GYPSUM BOARD FINISH

1. ERECT SINGLE LAYER 1/2" STANDARD, 5/8" F.R. AND 1/2" MOISTURE RESISTANT GYPSUM BOARD IN MOST ECONOMICAL DIRECTIONS, WITH ENDS OCCURRING OVER FIRM BACKING.


MIN. 6'-8" HEADROOM

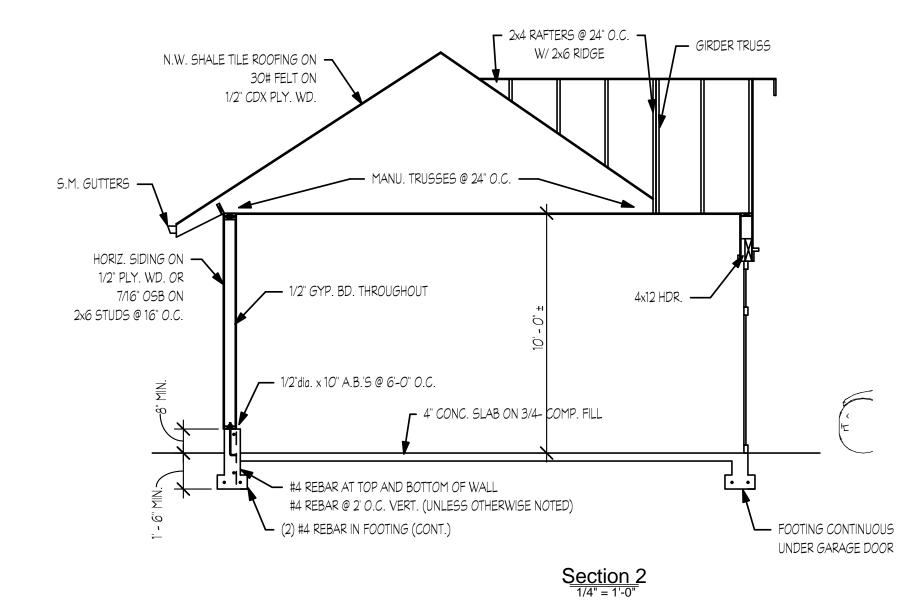

STAIR DETAIL

— 3 - 2x12 STRINGERS

— SIMPSON HANGERS

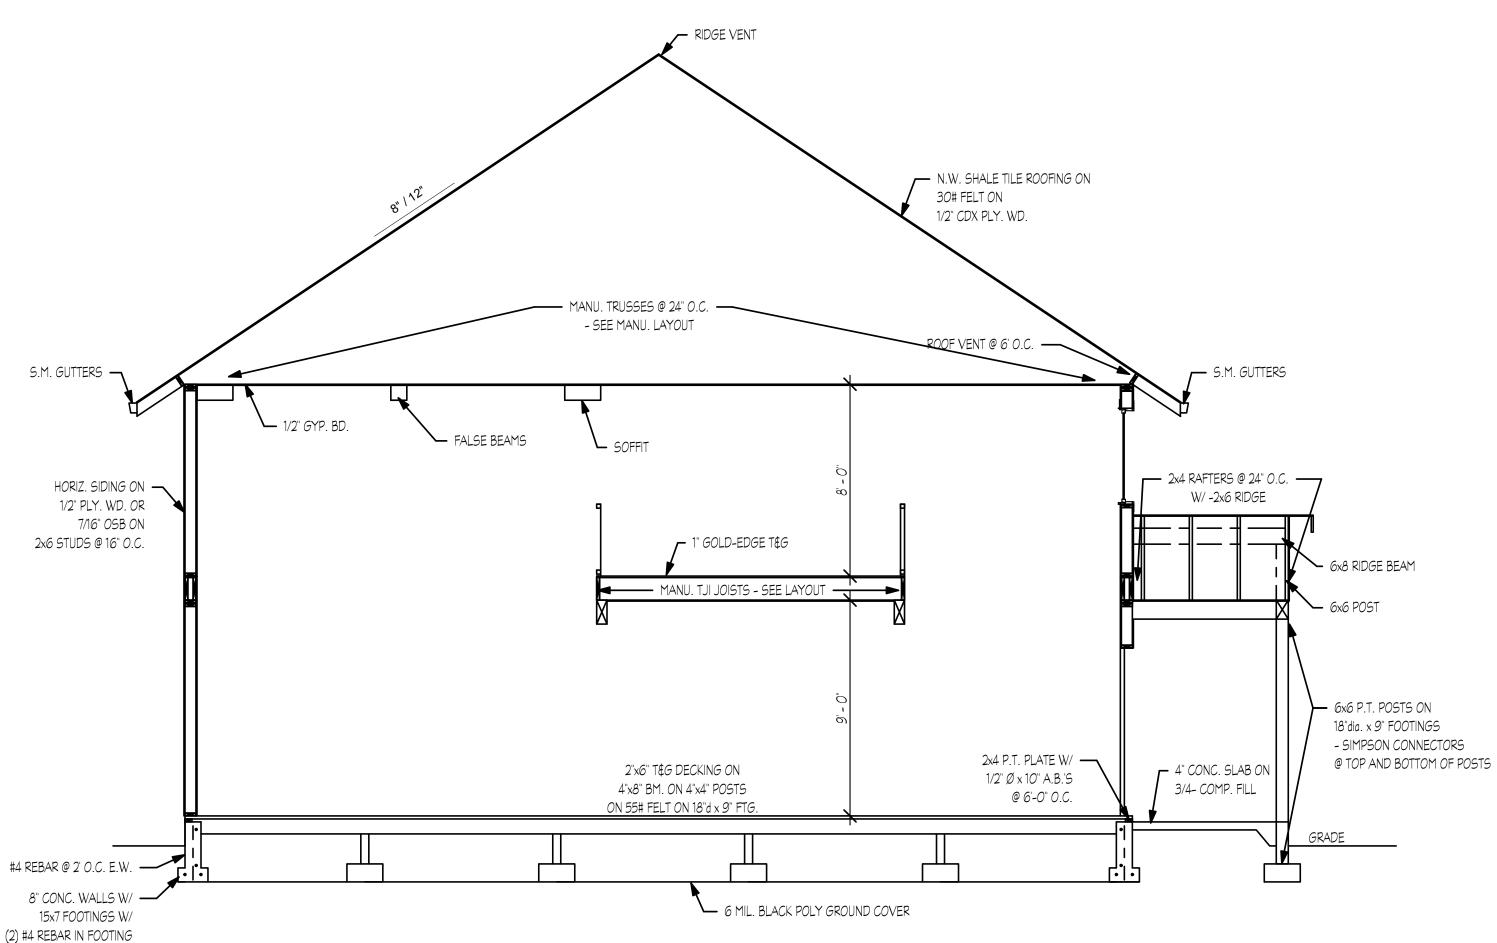

<u>Section</u> 1

Project number: 9586

Date: 1/3/10

Drawn by: BSY

Checked by: SGB

Area:

Scale: 1/4" = 1'-0"

Valley Homes

Willamette

SEC

NOTES,

GENER